



REVISIONS: FILE NAME: G:\NCD08\0101\0101\Drawings\E-104.dwg LAYOUT NAME: E-104 PLOTTED: Friday, July 16, 2010 - 9:43am

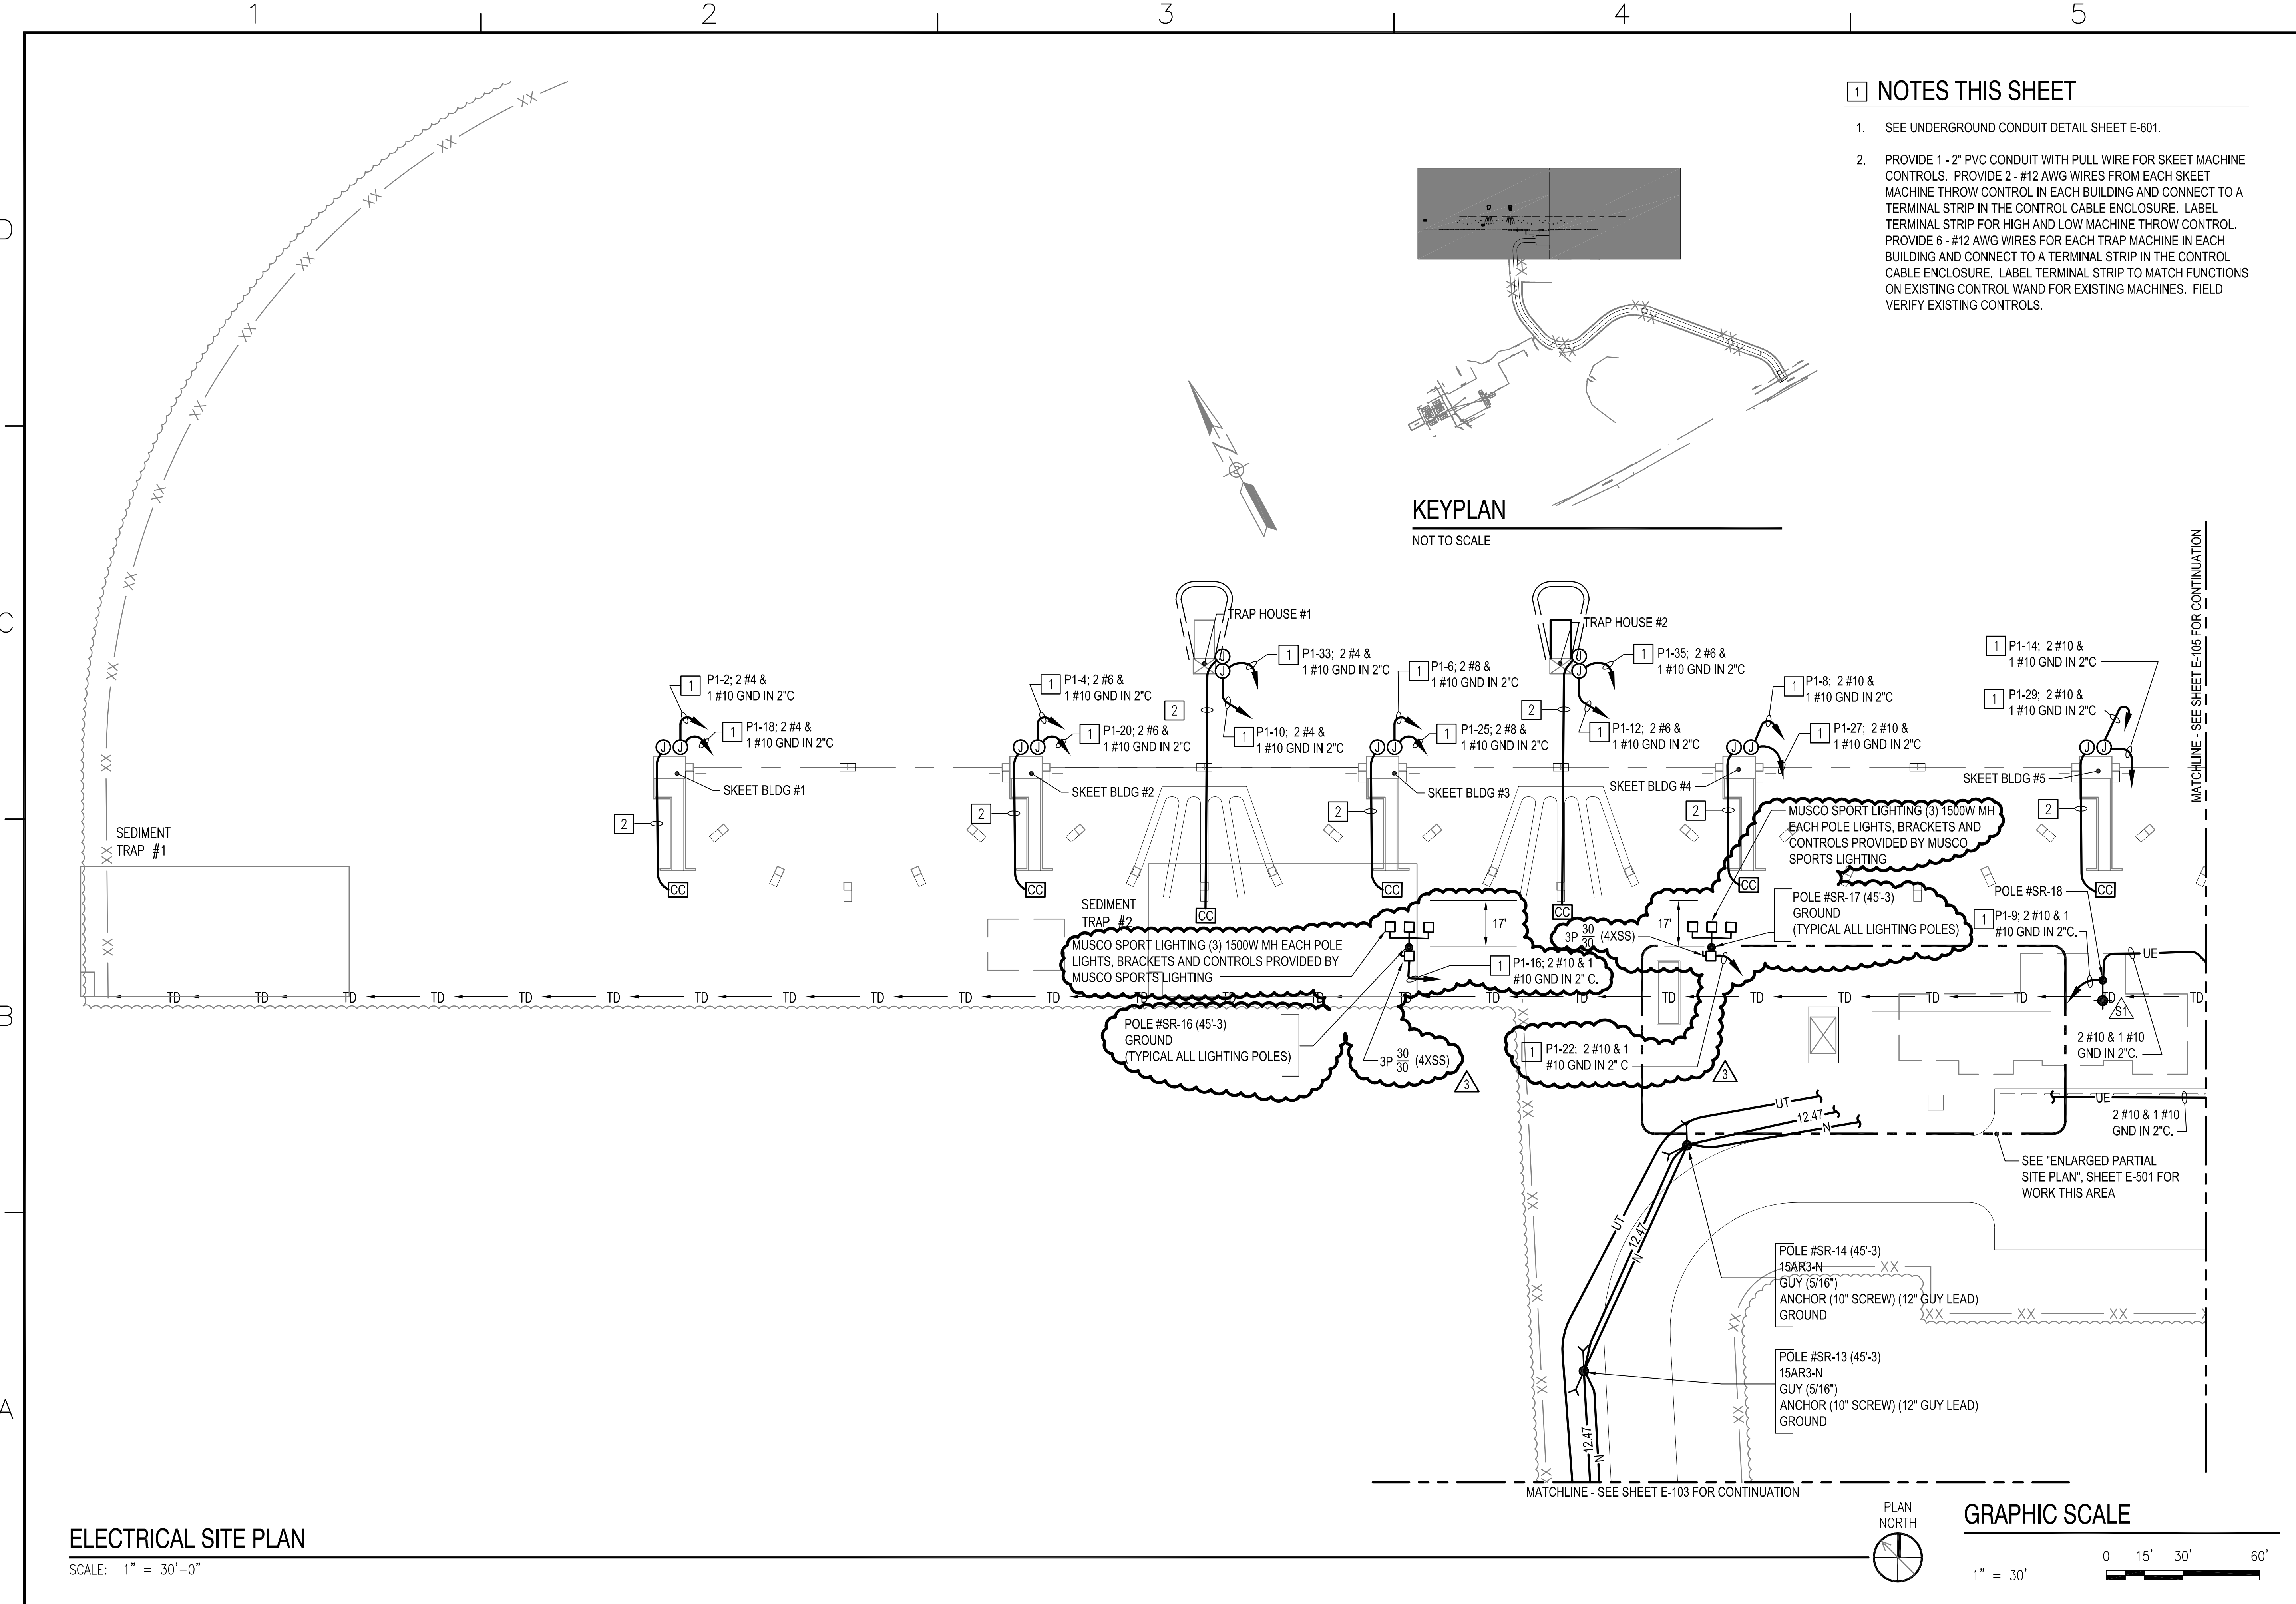


NOTES THIS SHEET

- SEE UNDERGROUND CONDUIT DETAIL SHEET E-601.
- PROVIDE 1 - 2" PVC CONDUIT WITH PULL WIRE FOR SKEET MACHINE CONTROLS. PROVIDE 2 - #12 AWG WIRES FROM EACH SKEET MACHINE THROW CONTROL IN EACH BUILDING AND CONNECT TO A TERMINAL STRIP IN THE CONTROL CABLE ENCLOSURE. LABEL TERMINAL STRIP FOR HIGH AND LOW MACHINE THROW CONTROL. PROVIDE 6 - #12 AWG WIRES FOR EACH TRAP MACHINE IN EACH BUILDING AND CONNECT TO A TERMINAL STRIP IN THE CONTROL CABLE ENCLOSURE. LABEL TERMINAL STRIP TO MATCH FUNCTIONS ON EXISTING CONTROL WAND FOR EXISTING MACHINES. FIELD VERIFY EXISTING CONTROLS.

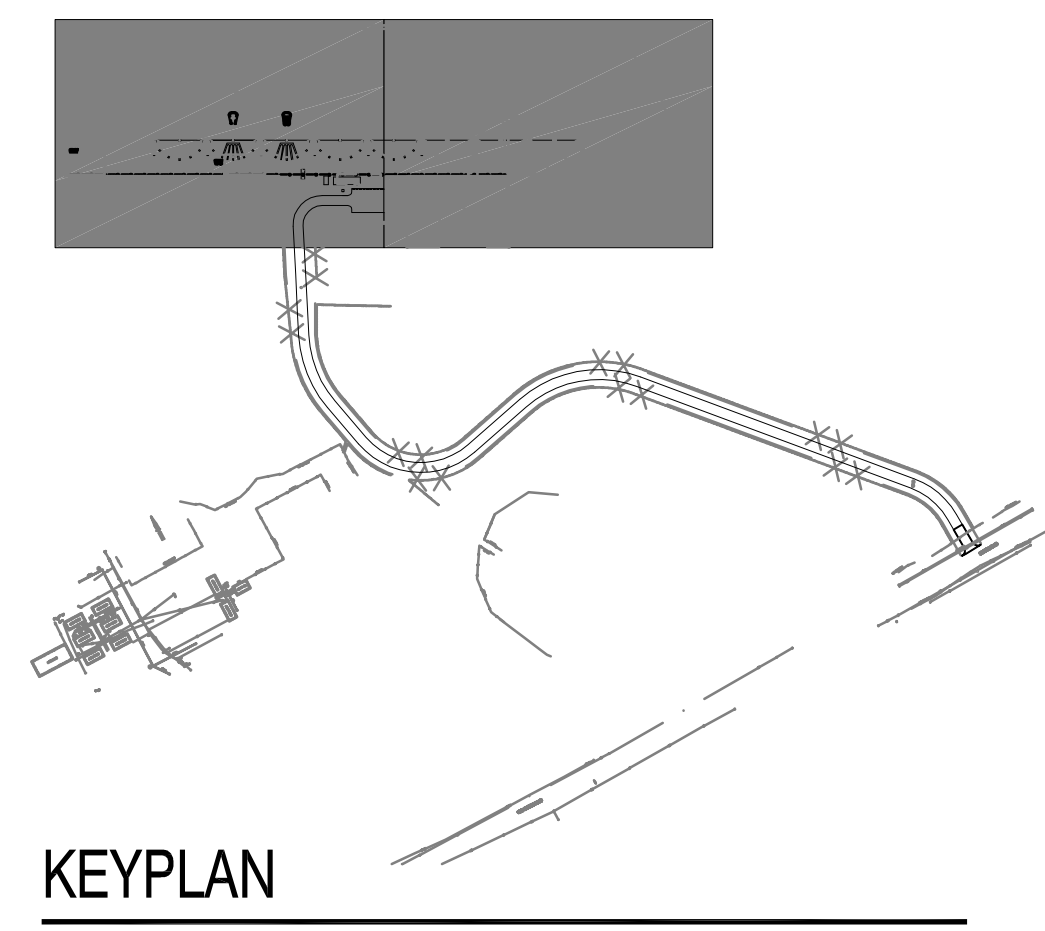

ELECTRICAL SITE PLAN
SCALE: 1" = 30'-0"

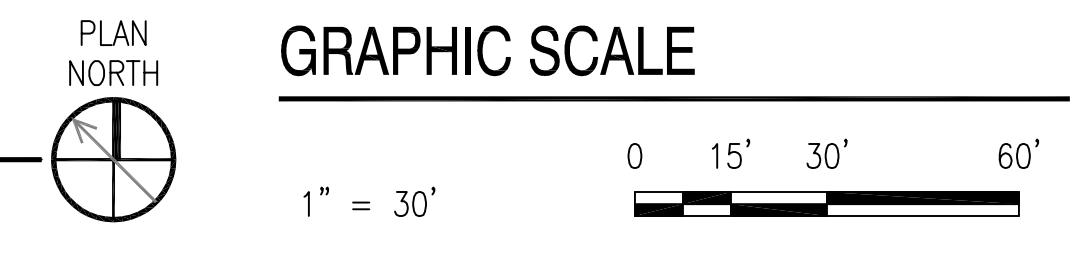

| | | | |
|---|----------|------|-----|
| DES | CJW | DRW | CJW |
| REVIEWED BY | ABA | | |
| PM/DM | | | |
| CHIEF ENG/ARCH | | | |
| DEPARTMENT OF THE NAVY NAVAL FACILITIES ENGINEERING COMMAND NAVAL STATION - NORFOLK, VA NORTH CAROLINA IPT MCB CAMP LEJEUNE RELOCATE SKEET RANGE SITE PLAN | | | |
| CODE ID NO. | 80091 | SIZE | D |
| SCALE: | AS NOTED | | |
| MAXIMO NO. | | | |
| STA. PROJ. NO. | P-1156B | | |
| WORK ORDER NO. | 797224 | | |
| CONSTR. CONTR. NO. | | | |
| NAVFAC DRAWING NO. | 12545152 | | |
| SHEET | 56 | OF | 66 |
| E-104 | | | |
| DRAWING REVISION: 01 MAY 2008 | | | |

